


SCHEDULE OF OPENINGS

TYPE	WIDTH	HEIGHT	SILT HT. UNITS
D1	750	2100	2100
D2	900	2100	2100
D3	1000	2100	2100
D4	1500	2100	2100
D5	2000	2100	2100
FCD	1500	2100	2100
W1	3425	2470	900
W2	4975	2470	900
W3	2380	2470	900
GL/D	6015	2500	2500
V1	650	920	2000
			2920


AREA DIAGRAM THIRD FLOOR

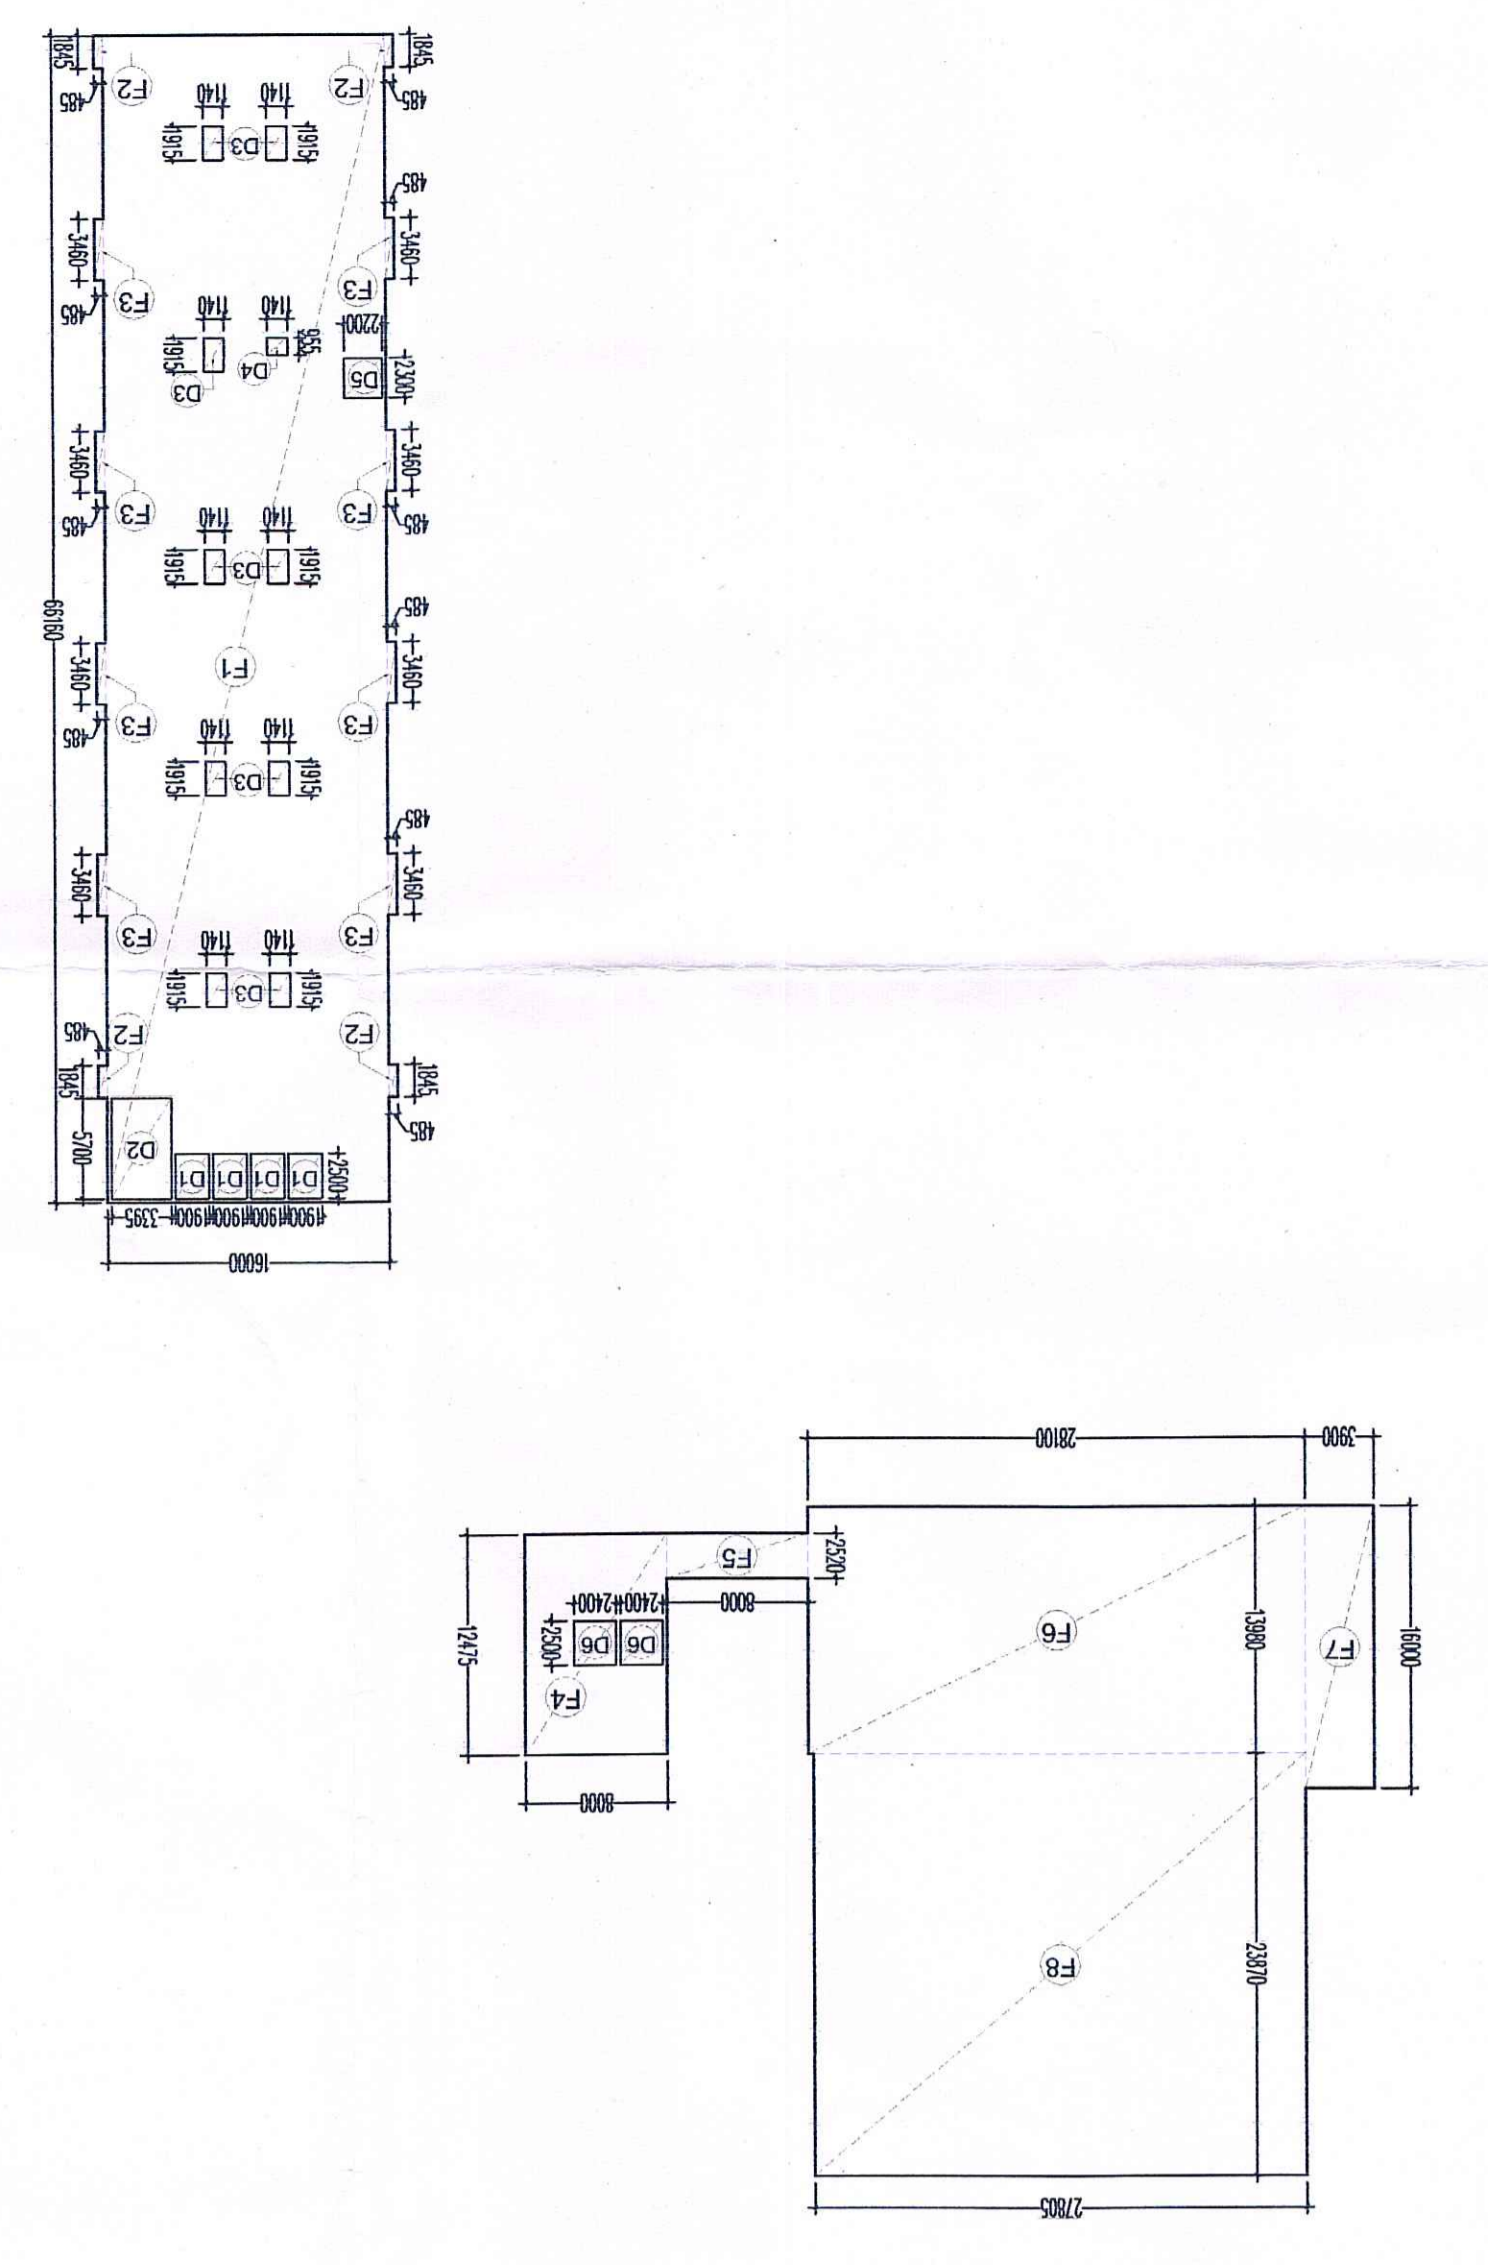

THIRD FLOOR PLAN
NO. OF SERVICE APARTMENT - 19


THIRD FLOOR AREA CALCULATION

Sr No	Dim (m)	X	Dim (m)	Nos	Area (SQM)
F1	16.00	X	66.16	1	1058.560
F2	0.485	X	1.845	4	3.579
F3	0.485	X	3.460	8	13.425
F4	8.00	X	12.475	1	99.800
F5	8.00	X	2.520	1	20.160
F6	28.10	X	13.980	1	392.838
F7	3.90	X	16.00	1	62.400
F8	27.805	X	23.870	1	663.705
DEDUCTION AREA					2314.467
D1	1.90	X	2.50	4	19.000
D2	3.95	X	5.70	1	19.352
D3	1.14	X	1.915	9	19.648
D4	1.14	X	0.955	1	1.089
D5	2.20	X	2.30	1	5.060
D6	2.40	X	2.50	2	12.000
TOTAL DEDUCTION AREA					76.148
TOTAL THIRD FLOOR FAR AREA (2314.467-76.148)					2238.319

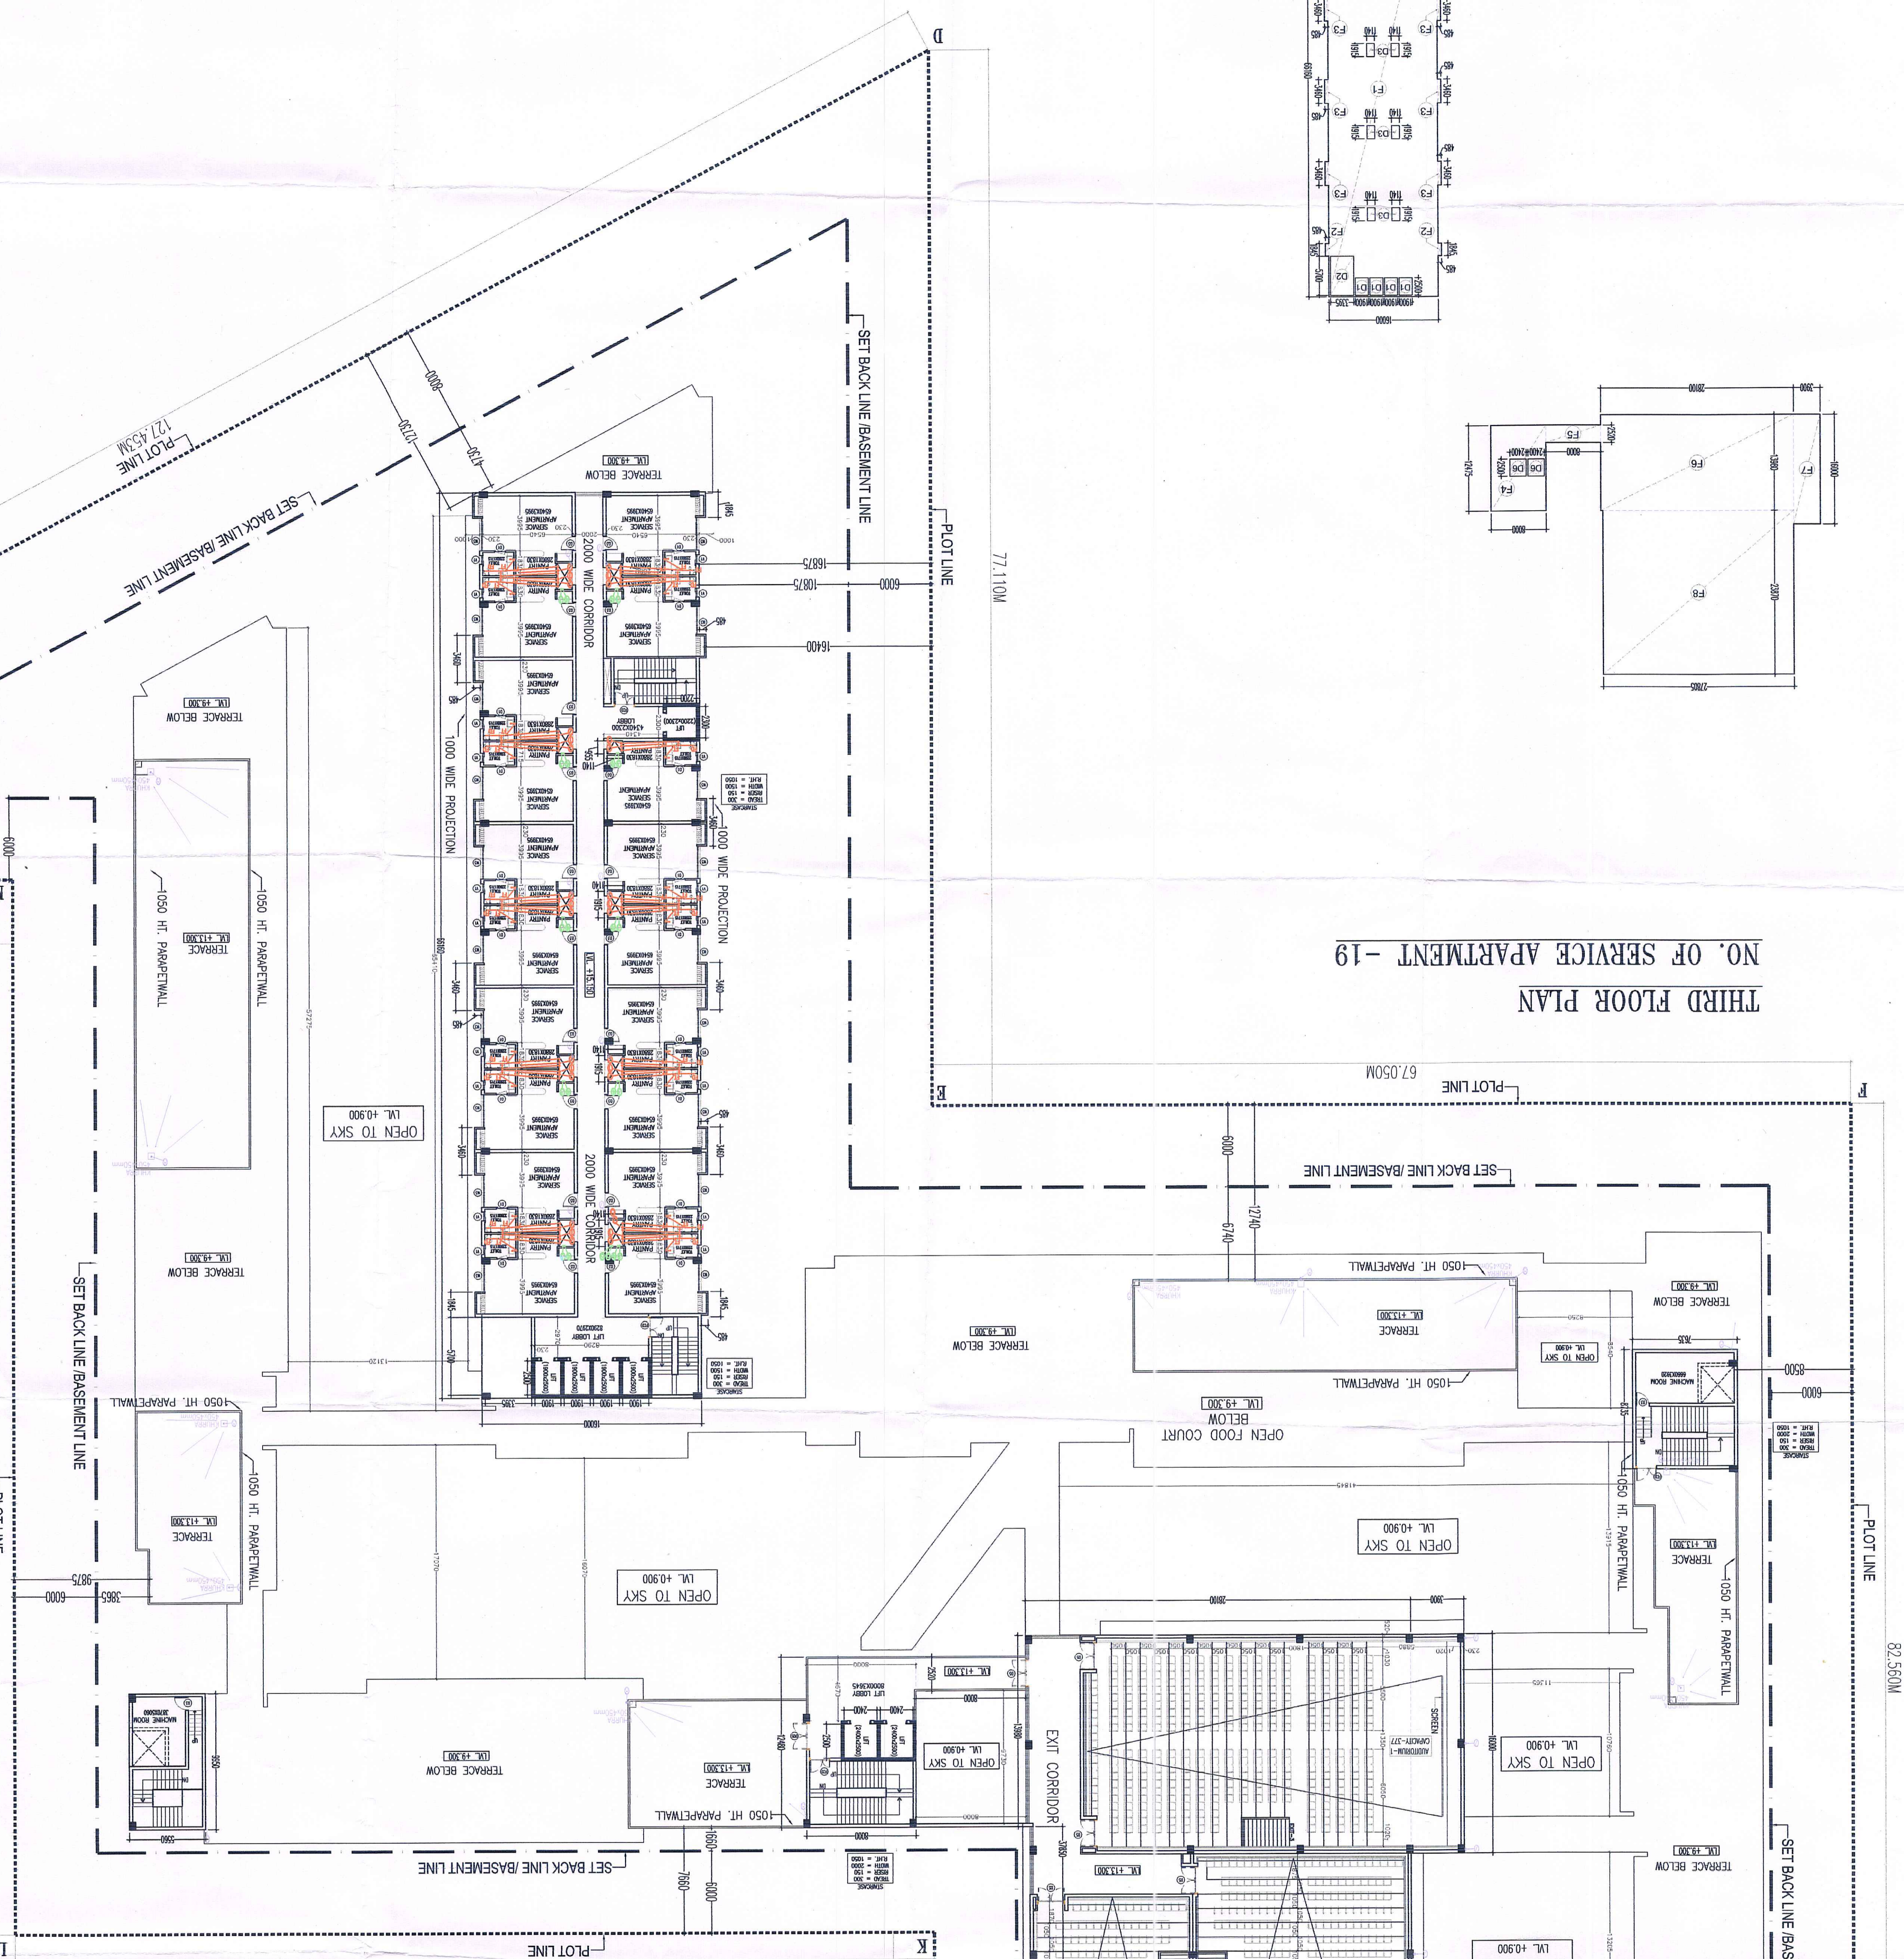

AREA DIAGRAM MUMTY & MACHINE ROOM
(NON FAR AREA)

M1 = 7.635 X 8.735 = 66.691 SQM
M2 = 5.560 X 9.950 = 55.322 SQM
TOTAL AREA = 122.013 SQM

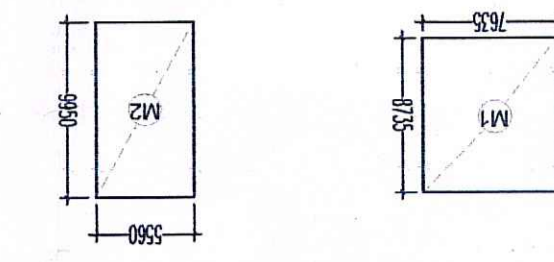

OWNER'S SIGN

ARCHITECT'S SIGN

THIRD FLOOR PLAN

SCALE: 1:200

DRG. NO. SB-07

DEALT: YUNUSH

CHKD: BIPIN

DATE: 26.06.2013

PROJECT: PROPOSED BUILDING PLANS OF COMMERCIAL COLONY AREA MASURING 3.040625 ACRES IN LICENSE NO. 53 OF 2013 DATED 20.06.2013 IN SECTOR - 90, GURGOAN-MANASAR URBAN COMPLEX BEING DEVELOPED BY CROWN PROPRITD PVT. LTD.

- LEGEND:-
- ① 100# H.C.L. WASTE & VENT PIPE
 - ② 100# H.C.L. SOIL & VENT PIPE
 - ③ C.M.S. DN. TAKE PIPE
 - ④ C.M.S. DN. TAKE PIPE
 - ⑤ C.M.S. RISER TO O.H.T. FILLING
 - ⑥ F.M.S. RISER TO O.H.T. FILLING
 - ⑦ 100 ØØ ØØ PVC RAIN WATER PIPE
 - ⑧ 150# H.C.L. WASTE & VENT PIPE
 - ⑨ 150# H.C.L. SOIL & VENT PIPE
 - ⑩ C.M.S. RISER TO MULTIPLEX TOILET SUPPLY
 - ⑪ F.M.S. RISER TO MULTIPLEX TOILET SUPPLY

NOTES

This development has been conceived, designed and drafted on the basis of the following:

- All useable office spaces/retail spaces (like SHOWROOM areas, entertainment and atrium) will be centrally air-conditioned. Therefore, no provision has been made for natural ventilation of spaces.
- All toilets/kitchens will be mechanically ventilated. Conditioned air from the floor will be sucked in to the toilets/kitchens and vented out through a vent shaft.
- All spaces (office spaces, retail spaces, service areas, parking basements) will be artificially lit. Any natural light which is available in the office spaces is only incidental and not essential to the functioning of the building.
- 100% standby generating capacity will be provided for the entire electrical requirement of the total scheme. This therefore includes standby generation for all common services, fire services, lifts etc. and also the entire electrical load for ventilation, air-conditioning, lights and all office equipment.
- Basement will be artificially ventilated.
- This building will be sprinkled as per NBC norms.

APPROVED

DATE: 26.06.13

SCALE: 1:200

DRG. NO. SB-07

DEALT: YUNUSH

CHKD: BIPIN